

NO.	BOTANICAL NAME	COMMON NAME	MIN. SIZE	PLANTING REMARKS
120	SABAL PALMETTO	PALM TREE	8'-10' Ht.	SPACING AS SHOWN
9	QUERCUS VIRGINIANA	LIVE OAK	8'–10' Ht. 2.5" CAL.	SPACING AS SHOWN
120	ERIOBOTRYA JAPONICA	LOQUAT TREE	3.4 GAL.	SPACING AS SHOWN
379	PODOCARPUS MACROPHYLLUS	JAPANESE YEW	2 GAL.	SPACING AS SHOWN
426	ILEX CORNUTA 'CARISSA'	CARISSA HOLLY	3 GAL.	4' O.C.
104	ILEX CRENATA 'JAPANESE HOLLY'	SKY PENCIL	3 GAL.	4' O.C.
55	LIGUSTRUM JAPONICUM	JAPANESE PRIVET	2 GAL.	4' O.C.
180	ELAEAGNUS PUNGENS	THORNY ELAEAGNUS	3' AT PLANTING	6'-8'' O.C.
	9 120 379 426 104 55	120 SABAL PALMETTO 9 QUERCUS VIRGINIANA 120 ERIOBOTRYA JAPONICA 379 PODOCARPUS MACROPHYLLUS 426 ILEX CORNUTA 'CARISSA' 104 ILEX CRENATA 'JAPANESE HOLLY' 55 LIGUSTRUM JAPONICUM	120SABAL PALMETTOPALM TREE9QUERCUS VIRGINIANALIVE OAK120ERIOBOTRYA JAPONICALOQUAT TREE379PODOCARPUS MACROPHYLLUSJAPANESE YEW426ILEX CORNUTA 'CARISSA'CARISSA HOLLY'104ILEX CRENATA 'JAPANESE HOLLY'SKY PENCIL55LIGUSTRUM JAPONICUMJAPANESE PRIVET	NO.BOTANICAL NAMECOMMON NAMESIZE120SABAL PALMETTOPALM TREE8'-10' Ht.9QUERCUS VIRGINIANALIVE OAK8'-10' Ht.120ERIOBOTRYA JAPONICALOQUAT TREE3.4 GAL.120ERIOBOTRYA JAPONICALOQUAT TREE3.4 GAL.379PODOCARPUS MACROPHYLLUSJAPANESE YEW2 GAL.426ILEX CORNUTA 'CARISSA'CARISSA HOLLY3 GAL.104ILEX CRENATA 'JAPANESE HOLLY'SKY PENCIL3 GAL.55LIGUSTRUM JAPONICUMJAPANESE PRIVET2 GAL.180ELAFAGNUS PLINGENSTHORNY ELAFAGNUS3' AT

PLANT LIST-OR EQUIVALENTS

O.C. - "ON CENTER" CAL. - "CALIPER AT 6" ABOVE GRADE" GAL. - "GALLON CONTAINER" MIN. PLANTING SIZE: SHADE TREES=2-2.5" CAL. MULTI-STEM= 8-10' SHRUBS= 12"

SHRUBS USED TO SATISFY THE BUFFERYARD REQUIREMENTS MUST BE 3 FEET TALL AT PLANTING

LANDSCAPE_NOTES:

- 1. EXISTING REGULATED & SIGNIFICANT TREES HAVE BEEN LOCATED BY FIELD SURVEY.
- 2. KEY LETTERS REFER TO PLANT LIST.
- 3. ALL PLANTS SHALL MEET OR EXCEED THE MINIMUM STANDARDS SET FORTH IN "THE AMERICAN STANDARD FOR NURSERY STOCK" BY THE AMERICAN ASSOCIATION OF NURSERYMEN.

- 4. ALL PLANTING BEDS SHALL RECEIVE A MIN. OF 4" MULCH.
- 5. ALL AREAS DISTURBED AND NOT SPECIFIED AS PLANTING BEDS WILL BE GRASSED.
- 6. SOLID WASTE WILL BE BY CURBSIDE PICKUP.
- 7. ALL MECHANICAL EQUIPMENT, INCLUDING ANY ROOFTOP EQUIPMENT, SHALL BE SCREENED.
- 8. CONTRACTOR SHALL USE WHATEVER METHOD OF TREE STAKING HE DEEMS FIT. HOWEVER, HE WILL BE HELD LIABLE FOR ANY DAMAGES CAUSED TO TREES BY IMPROPER STAKING METHODS (OR ABSENCE OF STAKING) AND IS RESPONSIBLE FOR UPRIGHT AND REPLANTING TREES WHICH ARE BLOWN OVER.
- 9. CONTRACTOR SHALL WARRANTY ALL TREES AND SHRUBS FOR A PERIOD OF ONE YEAR FROM THE DATE OF FINAL ACCEPTANCE OF THE WORK OF THE LANDSCAPE PLAN.
- 10. IF DISCREPANCIES OR AVAILABILITIES ARE FOUND IN THE PLANT SPECIES AND/OR MIN. SIZES REQ'D., CONTRACTOR SHALL NOTIFY LANDSCAPE ARCHITECT. SUBSTITUTIONS MAY BE MADE WITH AUTHORIZATION AS LONG AS THE PLANTS FOLLOW THE INTENDED FORM AND FUNCTION.
- 11. THE USE OF FABRIC DURING INSTALLATION OF PLANTINGS IS RECOMMENDED FOR WEED CONTROL. CONTRACTOR SHALL MAKE EFFORTS TO INCLUDE AND DISCLOSE TO OWNER UPON INSTALLATION OF PLANTINGS IF LANDSCAPE FABRIC OR OTHER ALTERNATIVE IS TO BE USED.
- 12. CONTRACTOR WILL NOT USE PLASTIC AS COMPARED TO LANDSCAPE FABRIC DURING PLANT INSTALLATION FOR WEED CONTROL.
- 13. IRRIGATION OF LANDSCAPED AREAS IS RECOMMENDED BUT NOT REQUIRED. OWNER SHALL CONTACT DESIGNER OR IRRIGATION SPECIALIST FOR INPUT.
- 14. ANY OVERHANGING LIVE OAKS SHALL BE PRUNED BY A CERTIFIED ARBORIST, AS ADVISED BY THE URBAN FORESTER.

CITY REQUIREMENTS:

- 1. ALL INTERIOR PLANTINGS SHALL BE CURBED OR OTHERWISE PHYSICALLY PROTECTED FROM VEHICULAR TRAFFIC.
- 2. THE OWNER IS RESPONSIBLE FOR MAINTAINING ALL REQUIRED PLANT MATERIAL AND PLANTING AREAS IN GOOD HEALTH AND APPEARANCE. ANY DEAD, UNHEALTHY OR MISSING PLANTS MUST BE REPLACED WITHIN 180 DAYS WITH VEGETATION WHICH CONFORMS TO THE INITIAL PLANTING RATES AND STANDARDS.
- 3. CONTRACTOR IS RESPONSIBLE FOR MAKING SURE ALL SIGNIFICANT TREES WILL BE PROTECTED DURING CONSTRUCTION BY UTILIZING TREE PROTECTION FENCING, AT ALL TIMES.
- 4. PRIOR TO ANY CLEARING, GRADING, OR CONSTRUCTION ACTIVITY, TREE PROTECTION FENCING WILL BE INSTALLED AROUND PROTECTED TREES OR GROVES OF TREES. NO CONSTRUCTION WORKERS, TOOLS MATERIALS, OR VEHICLES, ARE PERMITTED WITHIN THE TREE PROTECTION FENCING.
- 5. NO DISTURBANCE IS PERMITTED ON SITE UNTIL A TREE PERMIT IS ISSUED IN CONJUNCTION WITH ANY COUNTY, CITY, STATE AND FEDERAL PERMITS.
- 6. NO LAND DISTURBANCE INCLUDING TREE REMOVAL IS TO OCCUR OUTSIDE THE LIMITS OF DISTURBANCE AS SHOWN ON THE PLANS.
- 7. PROTECTIVE FENCING IS TO BE MAINTAINED THROUGHOUT THE DURATION OF THE PROJECT AND ALL LAND CLEARING AND CONSTRUCTION CONTRACTORS SHALL RECEIVE ADEQUATE INSTRUCTION ON TREE PROTECTION REQUIREMENTS AND METHODS.
- 8. NO EQUIPMENT IS ALLOWED ON THE SITE UNTIL ALL TREE PROTECTION FENCING AND SILT FENCING HAS BEEN INSTALLED AND APPROVED.
- 9. ALL PLANTINGS IN BUFFERYARDS TO BE XERIC LANDSCAPING AS THEY ARE NATIVE PLANTS NEEDING MINIMUM IRRIGATION.
- 10. ALL LANDSCAPE ISLANDS TO BE SEEDED WITH CENTIPEDE GRASS OR EQUIVALENT AS GROUND COVER.

	SUMMERW		1" = 50' Date	GSP	Drawn By	Date	0. Revision	No.
GSP October 2015 License # Job No. P-0718 2015-0006 Wilmington New Hand		Wilmington	Job No.		License #			

<u>Trees</u> ÷ . Kagen - QV * – SP

<u>Plant Key</u>

<u>Shrubs</u>

⊙ – IC 🛛 — JH

🛞 – LJ


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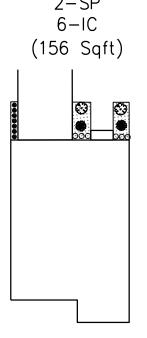
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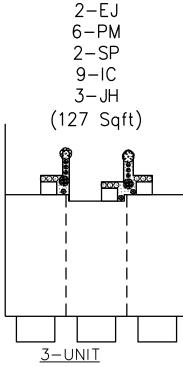
— PM

– EP

TYPICAL FOUNDATION PLANTINGS





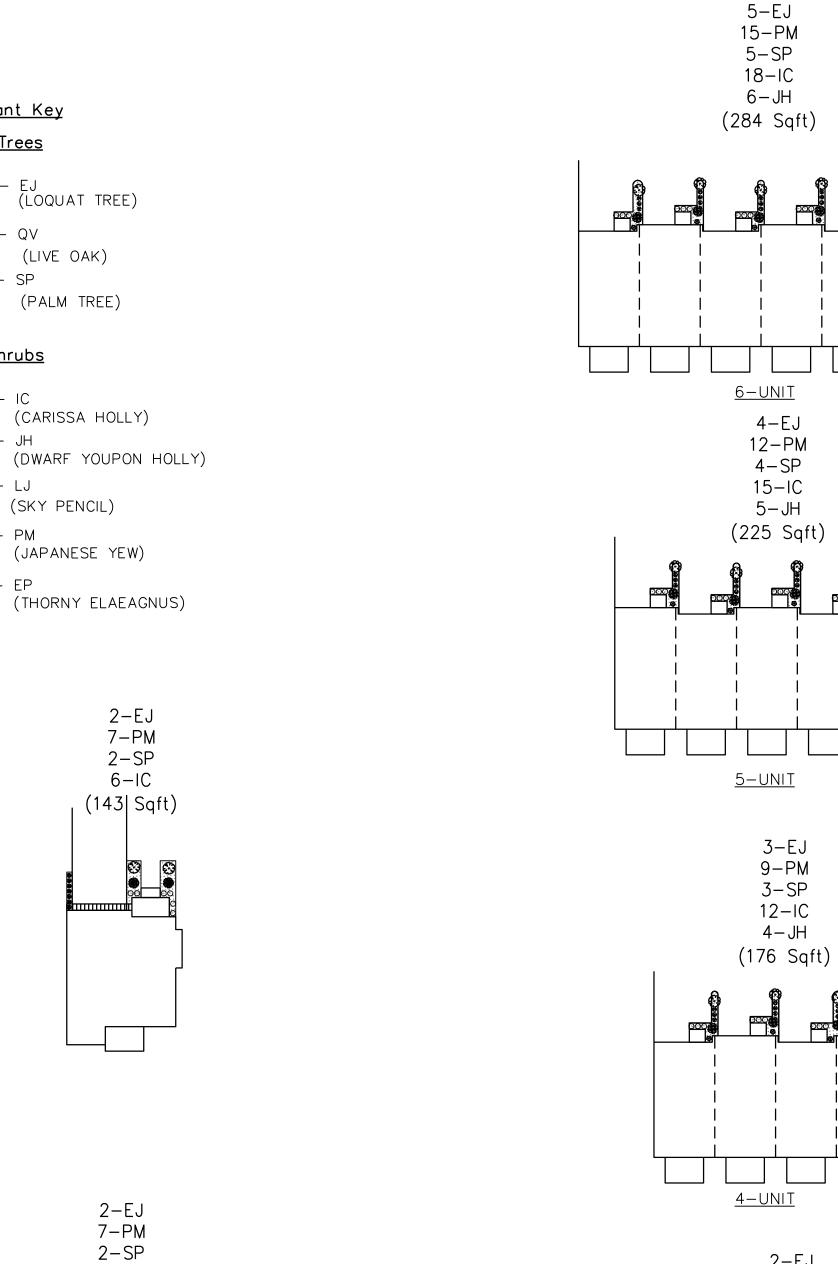

3-EJ

3–SP

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			PREPAR
K - PHASE 1		LANDSCAPING DETAILS	Summerwalk D 6105 Ole
County	North Carolina		Suit Wilmingto

Landscape Calculations:	(Note: All regulated & signific have been field located and	
Oleander Drive Streetyard	Req'd.	Prov'd.
503 I.f. frontage - 58' driveways =4451 I.f. X 18 (CB District factor)	8,010 s.f.	TO BE COMPLETED
© 1 tree / 600 s.f. © 6 shrubs / 600 s.f.	13 80	WITH PHASE 2
Greenville Loop Road Secondary Streetyard 732 I.f. frontage — 120' driveways =612 I.f. X 9 (MF District factor)	5,508 s.f.	6,793 s.f.
© 1 tree / 600 s.f. © 6 shrubs / 600 s.f.	9 55	9 55
Bufferyords - 1,460 l.f. buffer length @ 1 tree / 30 l.f.	49	49
Foundation Plantings – TOWNHOME BUILDINGS – 2,198 I.f. X 30' fac SINGLE FAMILY HOMES – 682 I.f. X 35' facc		9,100 s.f. <u>2,873 s.f.</u> 11,973 s.f. (TOTAL)
Overall Development Area — 20.19 ac.± Phase 1 development area x 15	o trees/ac. 303	173 PROPOSED 216 EXISTING 168 RELOCATED 557 TOTAL

MITIGA	TION CALCULA	TIONS
TREE TO BE	DIAMETER	# OF TREES
REMOVED	(in)	REQUIRED
MAGNOLIA	12	8
MAGNOLIA	18	12
SYCAMORE	27	18
	TOTAL	38*

*EXISTING TREES 2"-5" DBH TO BE RETAINED ON SITE AND SUPPLEMENTED WITH 168 RELOCATED TREES

OFFSITE SW PON		
TREE TO BE	# OF TREES	# OF TREES
REMOVED	<i>"</i> or meeo	REQUIRED
12" MAGNOLIA	1	8
18" MAGNOLIA	1	12
11" OAK	1	4
12" OAK	1	4
13" OAK	1	4
16"OAK	1	5
12"PINE	35	70
13" PINE	7	15
14" PINE	4	9
15"PINE	2	5
16"PINE	5	13
17" PINE	1	3
18"PINE	3	9
19" PINE	1	3
21"PINE	1	4
22" PINE	1	4
25" PINE	1	4
	TOTAL	177*

*EXISTING TREES 2"-5" DBH TO BE RETAINED ON SITE AND SUPPLEMENTED WITH 168 RELOCATED TREES

	Approved Construction Plan Name Date Planning
	For each open utility cut of View of City streets, a \$325 permit Public Services • Engineering Division APPROVED STORMWATER MANAGEMENT PLAN Date: Permit # Signed:
EPARED FOR: valk Development, LLC 5 Oleander Drive Suite 201 hington, NC 28403	GSP CONSULTING, PLLC ENGINEERING 6626 Gordon Road Unit C Wilmington, North Carolina 28411 tel: 910-442-7870 fax: 910-799-6659